


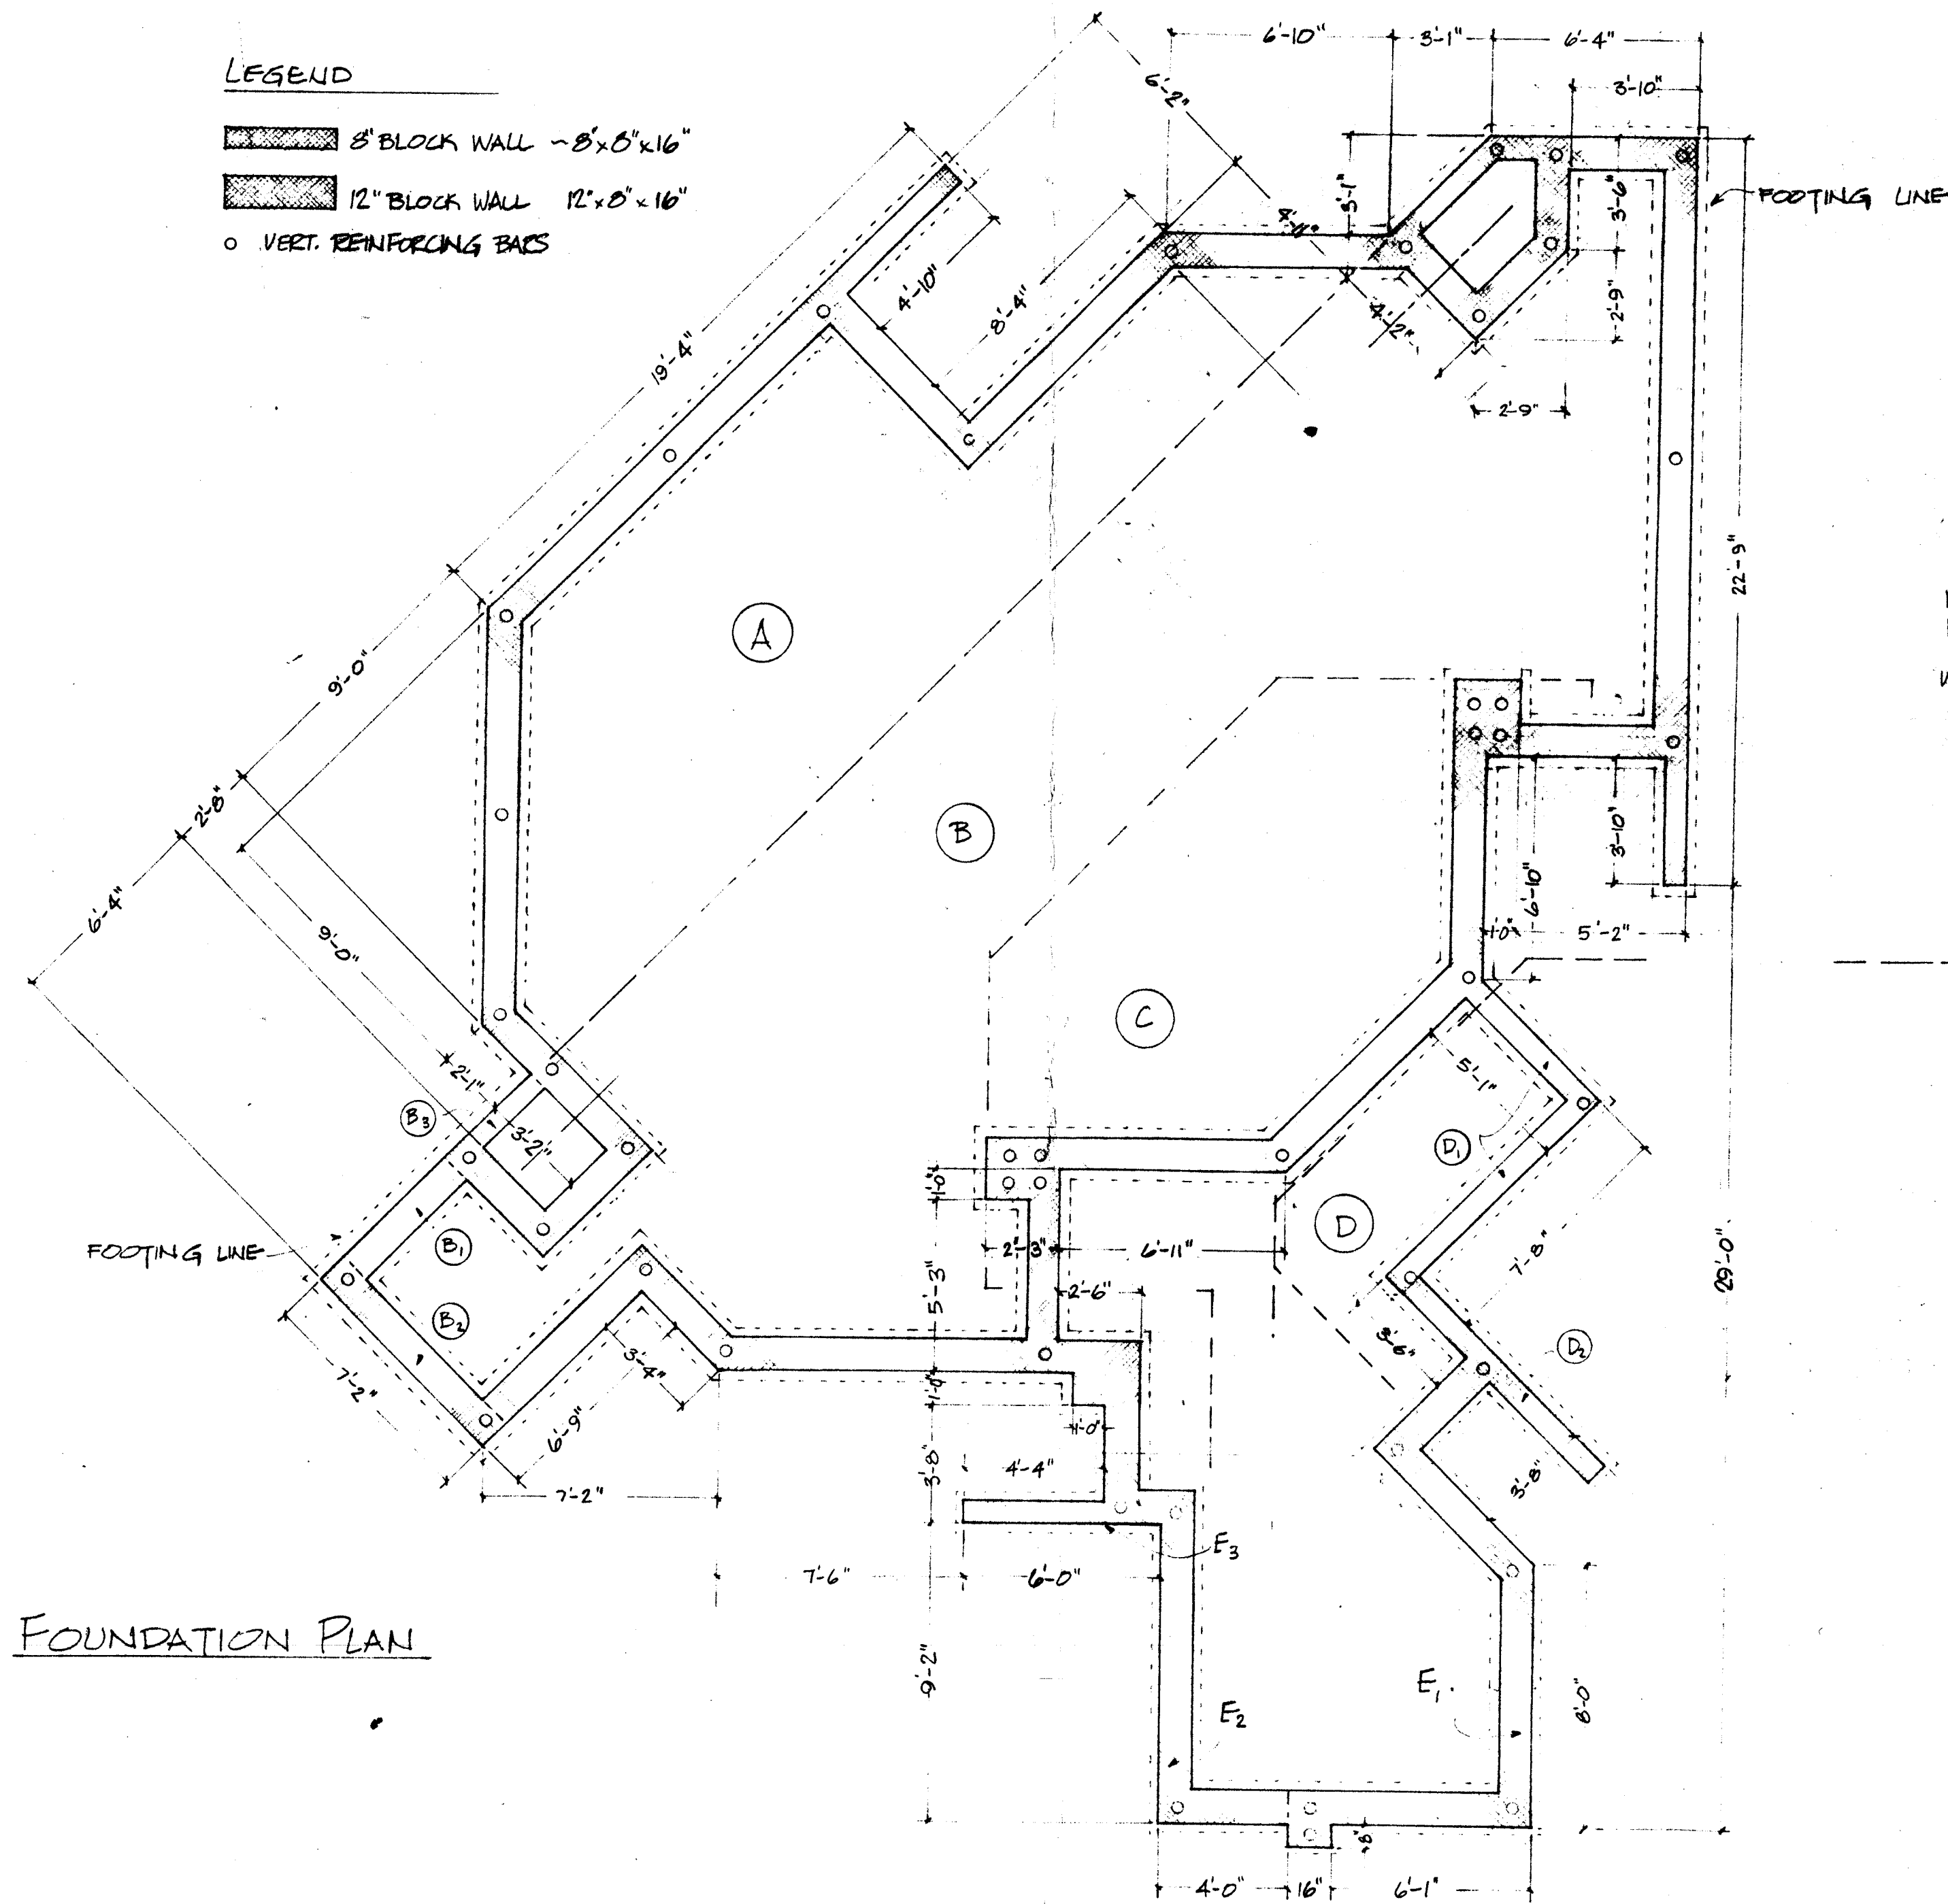


1
LONDONDERRY N.H. BANDSHELL
DESIGNER: JEFFREY GUTZHEON
PLAN: _____
SCALE: 1"=4'-0"

LEGEND

-  8" BLOCK WALL - 8"x8"x16"
-  12" BLOCK WALL - 12"x8"x16"
-  VERT. REINFORCING BARS




FOUNDATION PLAN

WALL HEIGHT SCHEDULE

SECTION OR WALL	# COURSES 12" BLOCK	# COURSES 8" BLOCK
A	6	4
B	6	6
B ₁	6	7
B ₂	6	10
B ₃	-	7
C	6	21
D	-	25
D ₂	-	14
E ₁	6	6
E ₂	6	4
E ₃	-	10


NOTE: 8" BLOCK CONTINUES OVER 12" BLOCK FLUSH TO OUTSIDE SURFACE (AWAY FROM CENTER STAGE)

WALLS DENOTING END OF STAIR RUN: 9 COURSES IN SECTION A; 10 COURSES ELSEWHERE. FINISH LEVEL WITH DECK OR SLAB WITH BRICK.

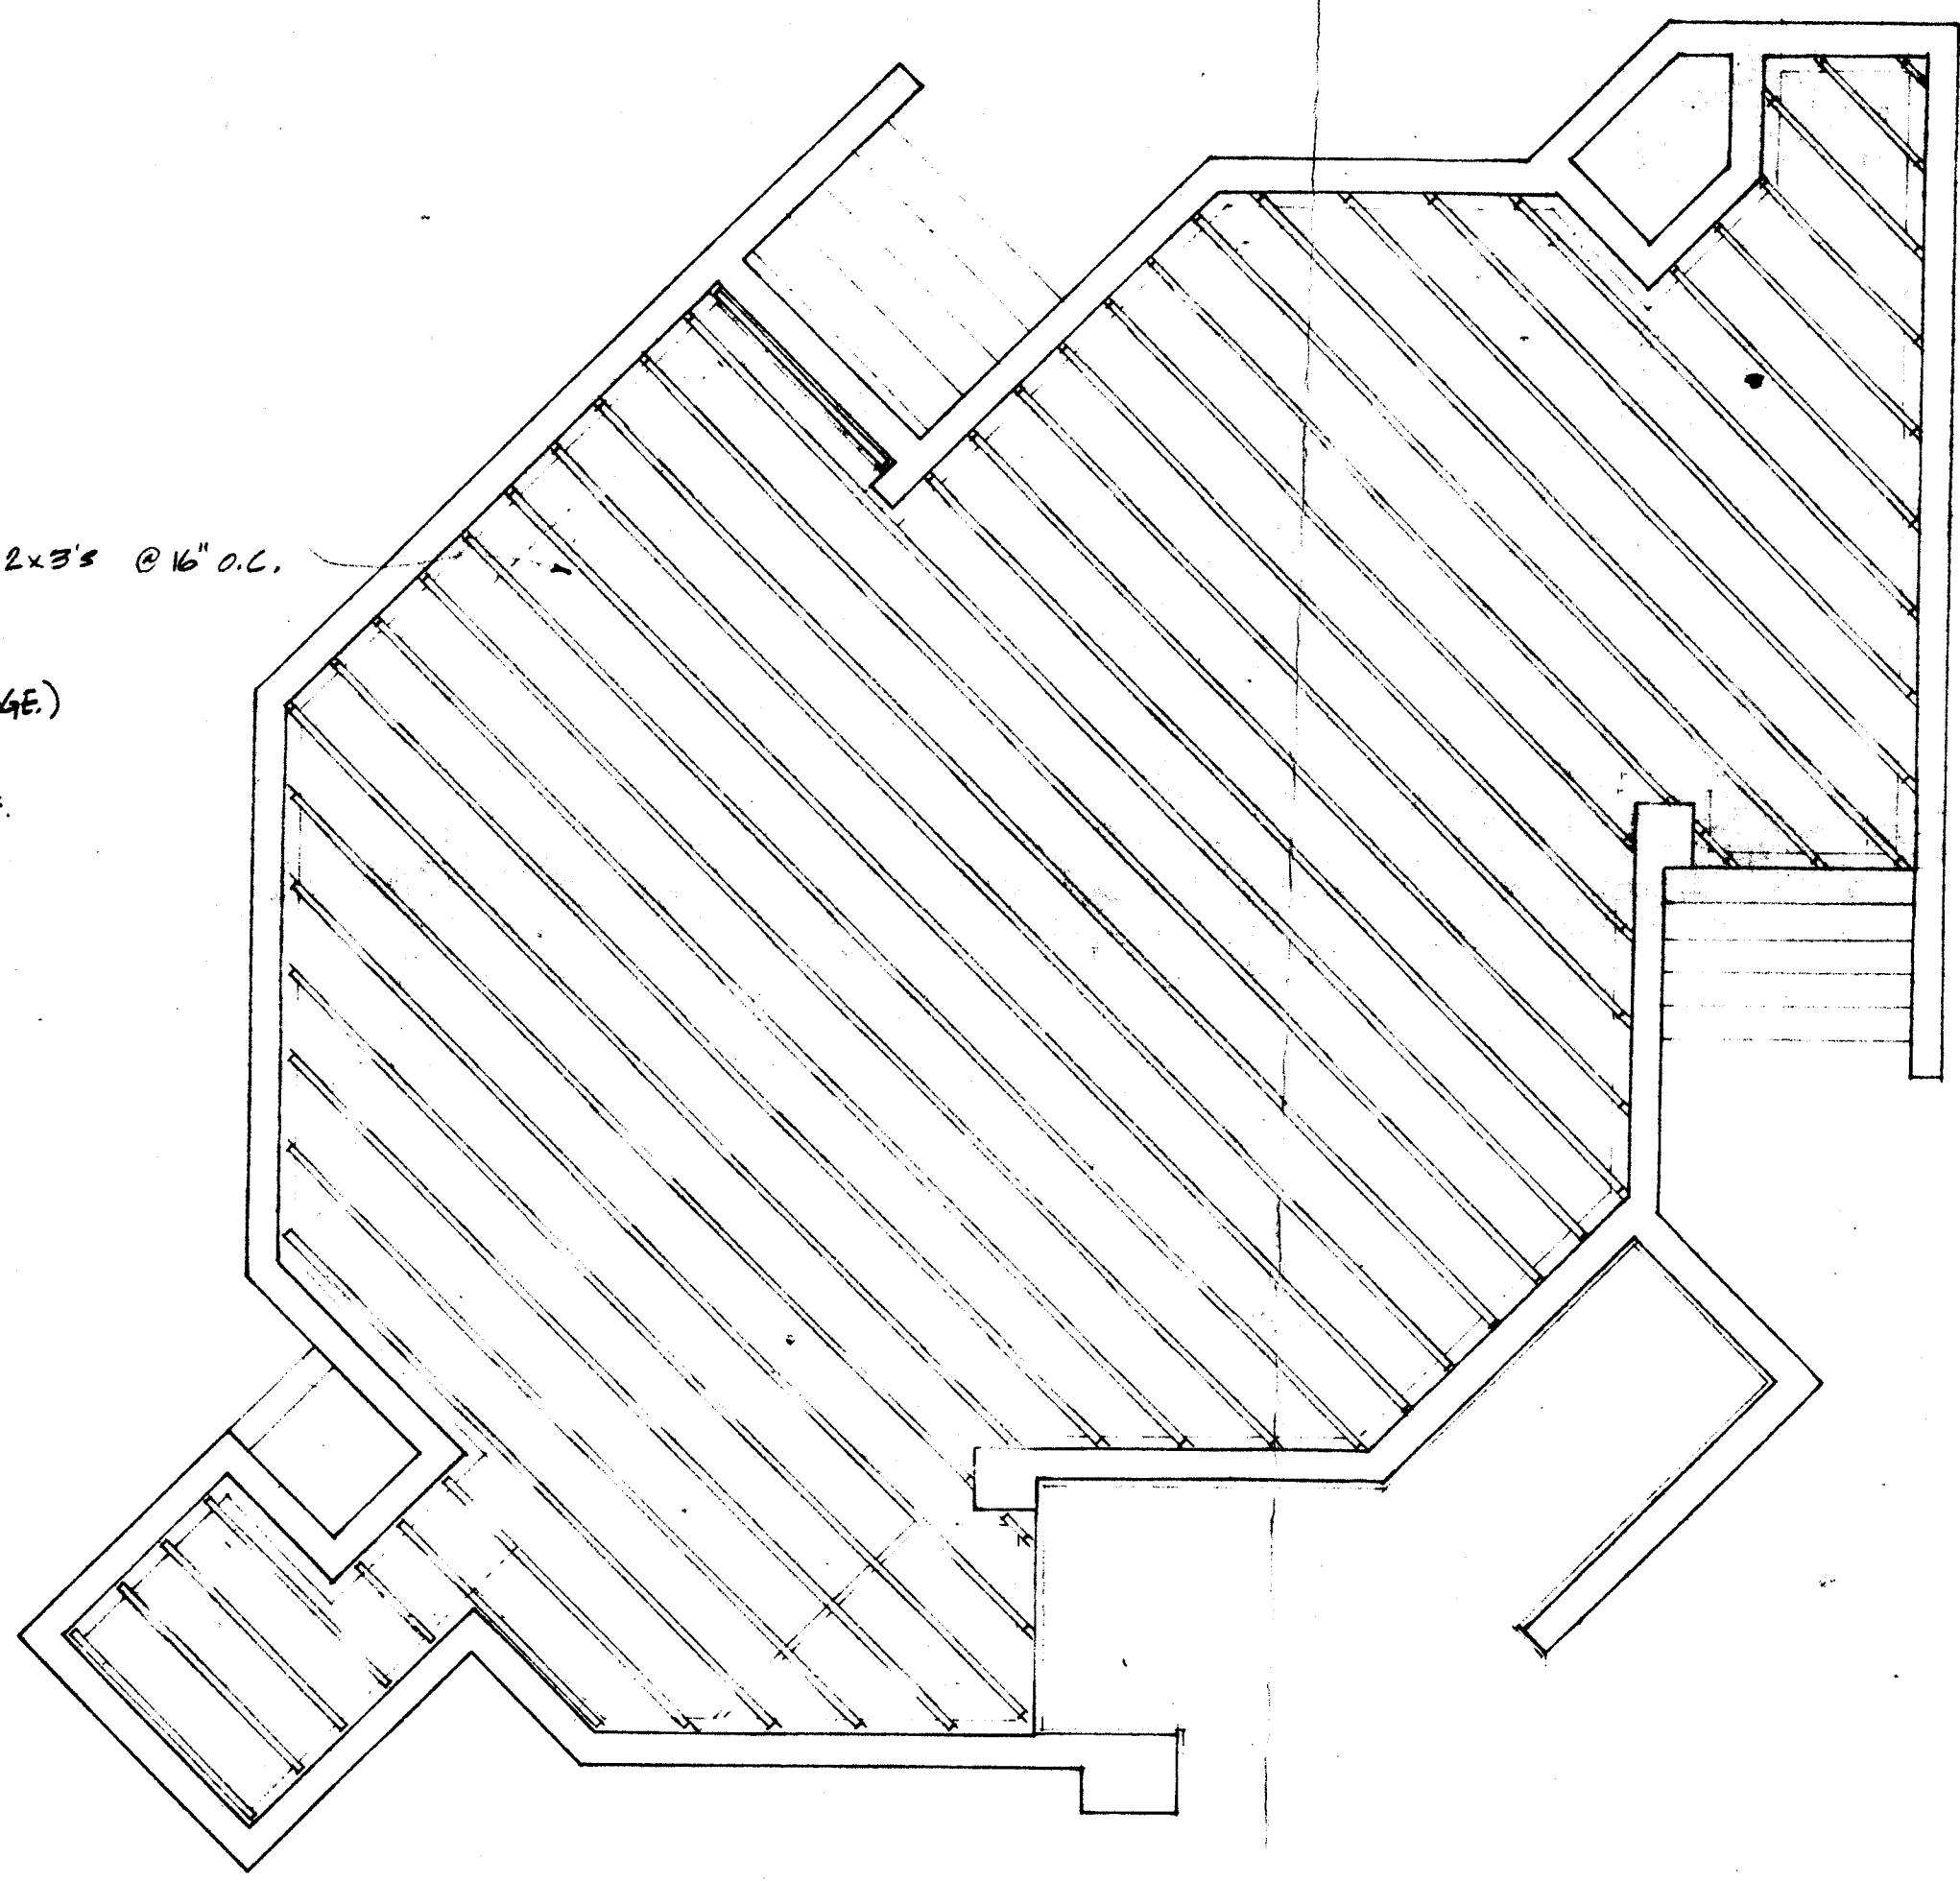

SLEEPER PLAN



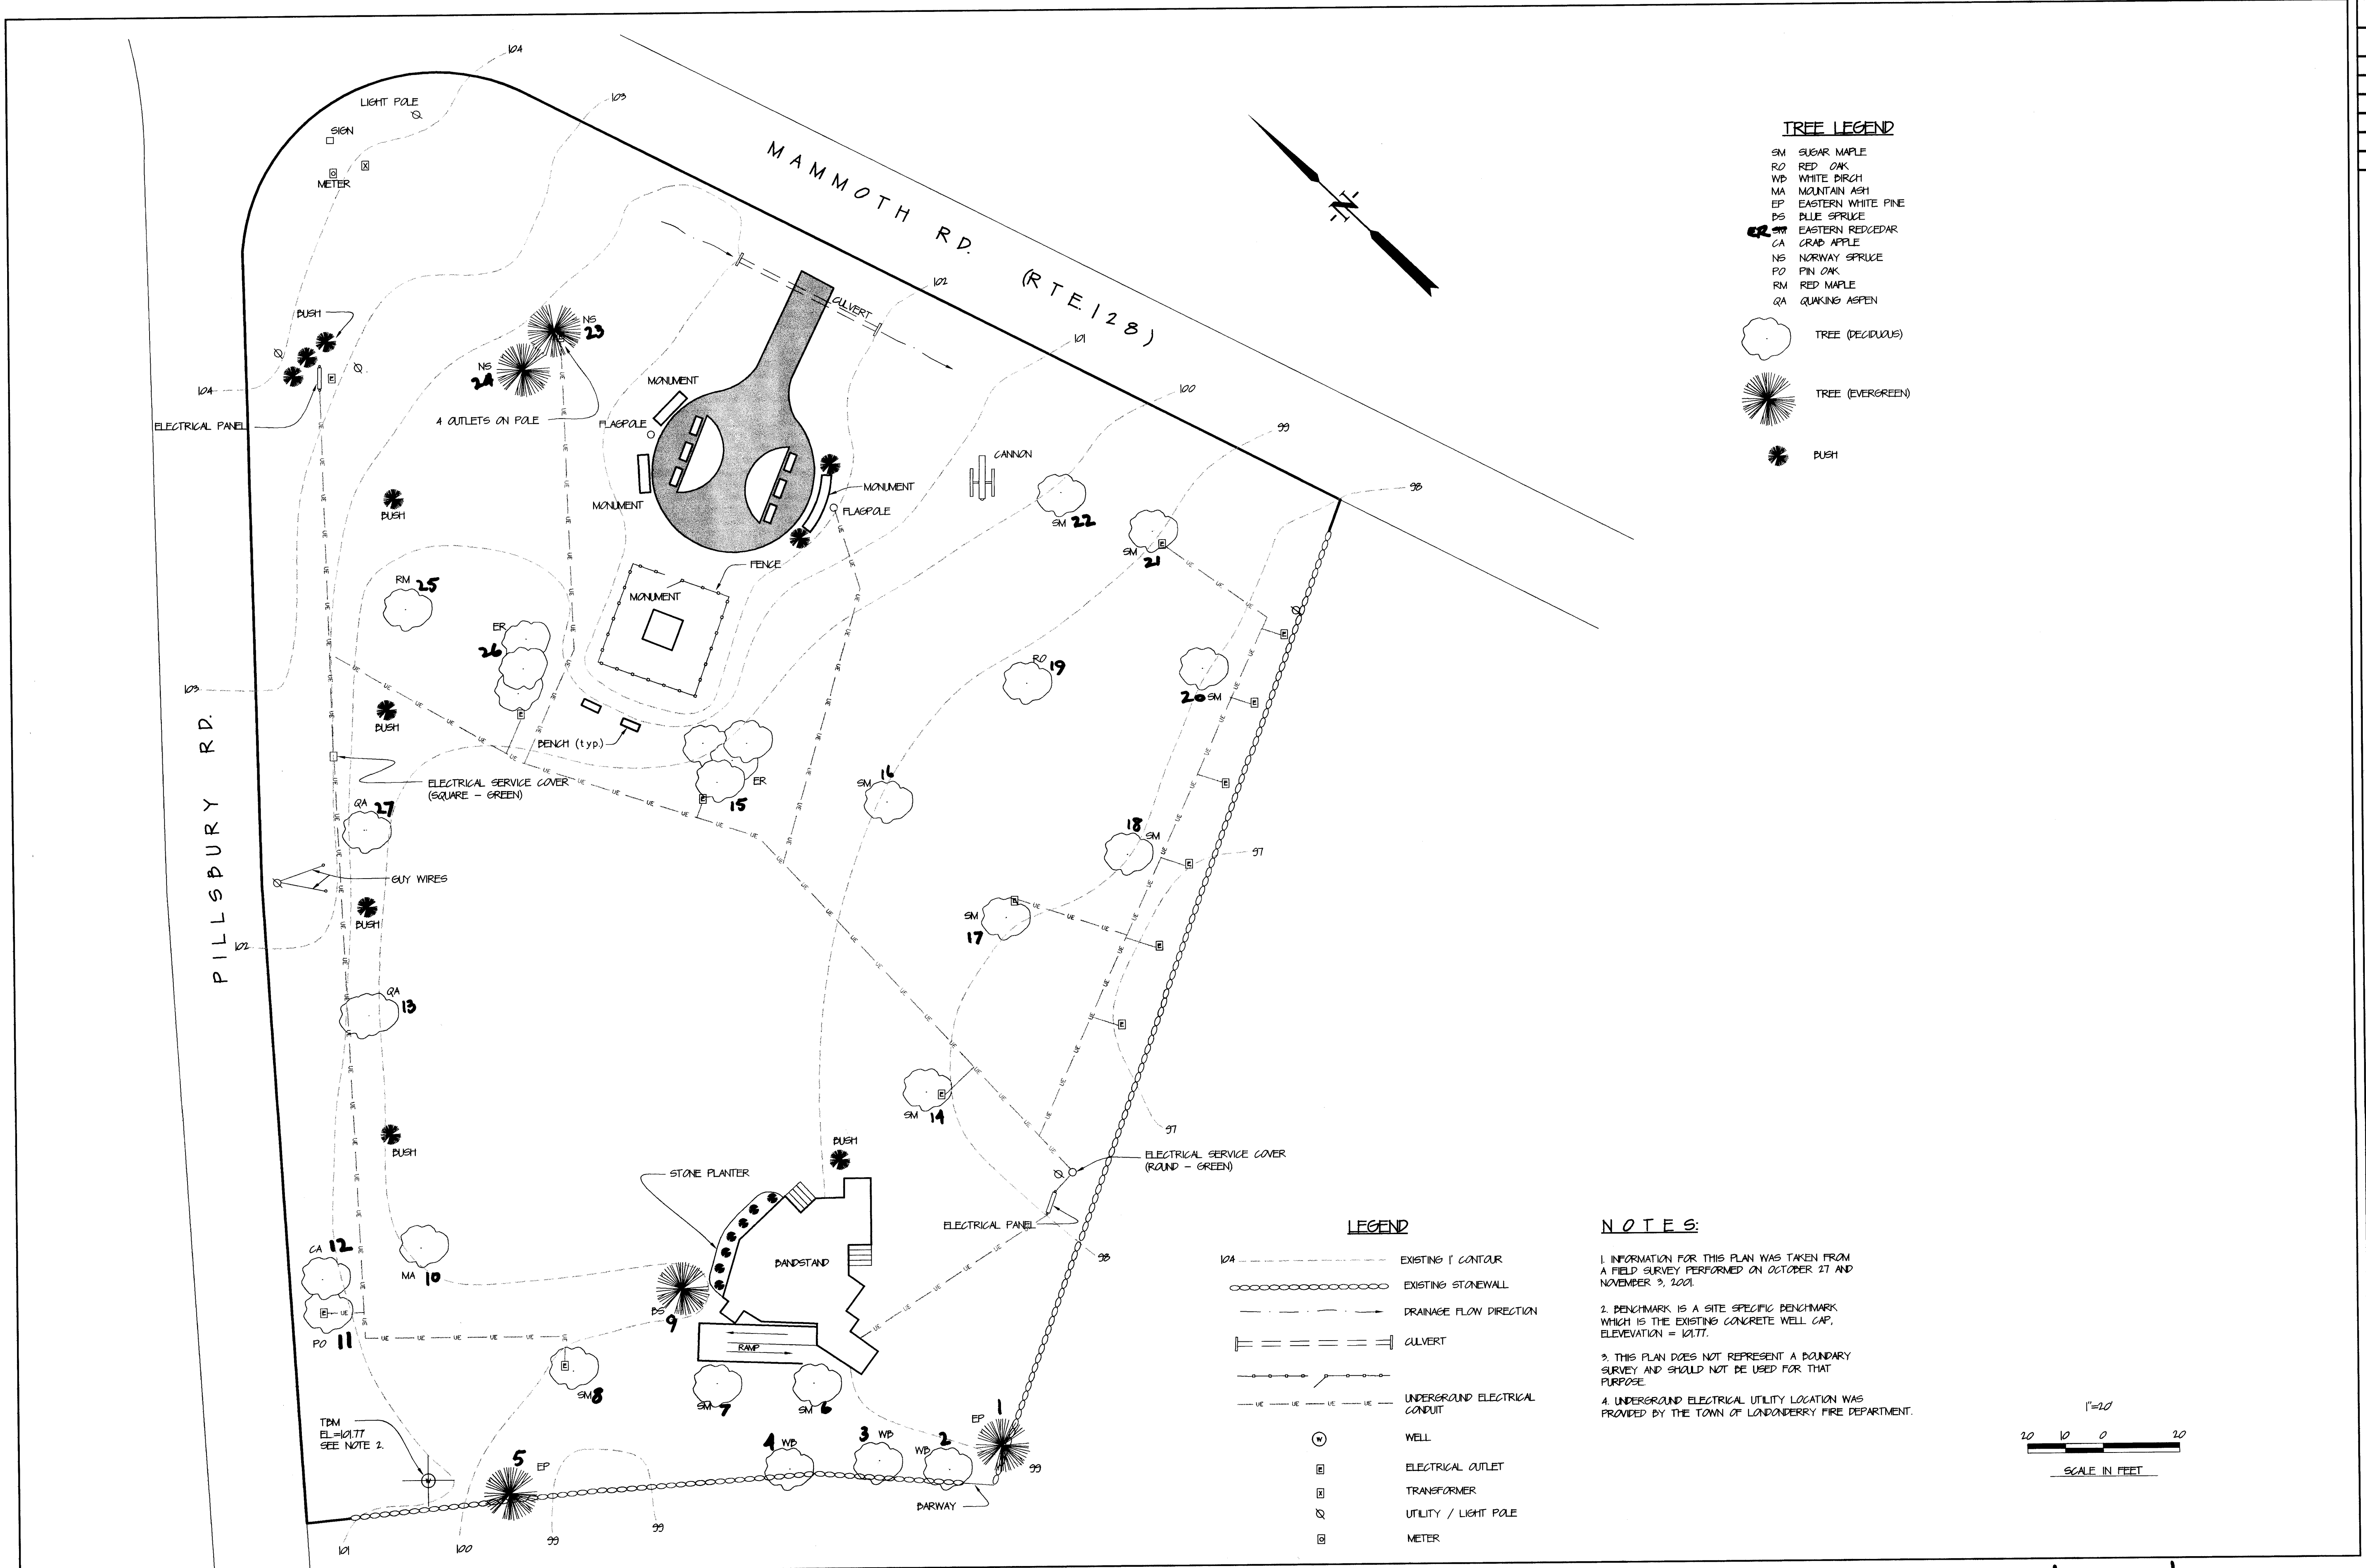




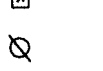


3 LONDONDERRY N.H. BANDSHELL
 DESIGNER: JEFFREY GUTCHEON
 PLANS SCALE: 1"=4'-0"



TREE LEGEND


- SM SUGAR MAPLE
 - RO RED OAK
 - WB WHITE BIRCH
 - MA MOUNTAIN ASH
 - EP EASTERN WHITE PINE
 - BS BLUE SPRUCE
 - ER EASTERN REDCEDAR
 - CA CRAB APPLE
 - NS NORWAY SPRUCE
 - PO PIN OAK
 - RM RED MAPLE
 - QA QUAKING ASPEN
-  TREE (DECIDUOUS)
 TREE (EVERGREEN)
 BUSH

LEGEND

-  EXISTING 1' CONTOUR
-  EXISTING STONEWALL
-  DRAINAGE FLOW DIRECTION
-  CULVERT
-  UNDERGROUND ELECTRICAL CONDUIT
-  WELL
-  ELECTRICAL OUTLET
-  TRANSFORMER
-  UTILITY / LIGHT POLE
-  METER

NOTES:


1. INFORMATION FOR THIS PLAN WAS TAKEN FROM A FIELD SURVEY PERFORMED ON OCTOBER 27 AND NOVEMBER 3, 2001.
2. BENCHMARK IS A SITE SPECIFIC BENCHMARK WHICH IS THE EXISTING CONCRETE WELL CAP, ELEVATION = 121.77.
3. THIS PLAN DOES NOT REPRESENT A BOUNDARY SURVEY AND SHOULD NOT BE USED FOR THAT PURPOSE.
4. UNDERGROUND ELECTRICAL UTILITY LOCATION WAS PROVIDED BY THE TOWN OF LONDONDERRY FIRE DEPARTMENT.

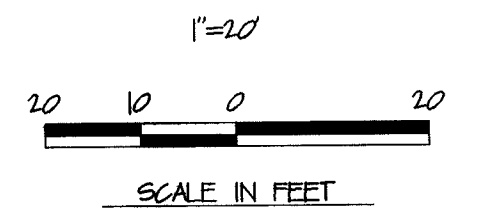


TOWN OF LONDONDERRY, NEW HAMPSHIRE
TOWN COMMON EXISTING CONDITIONS PLAN
 DATE: JANUARY 2002
 PROJECT NO: 1
 FILENAME: TOWNPARK.DWG
 SHEET NO: 01 OF 01
 DRAWING NO:

DRAFT.

**EAGLE PROJECT: MICHAEL HERRMANN
 T426 LONDONDERRY, NH
 2002**

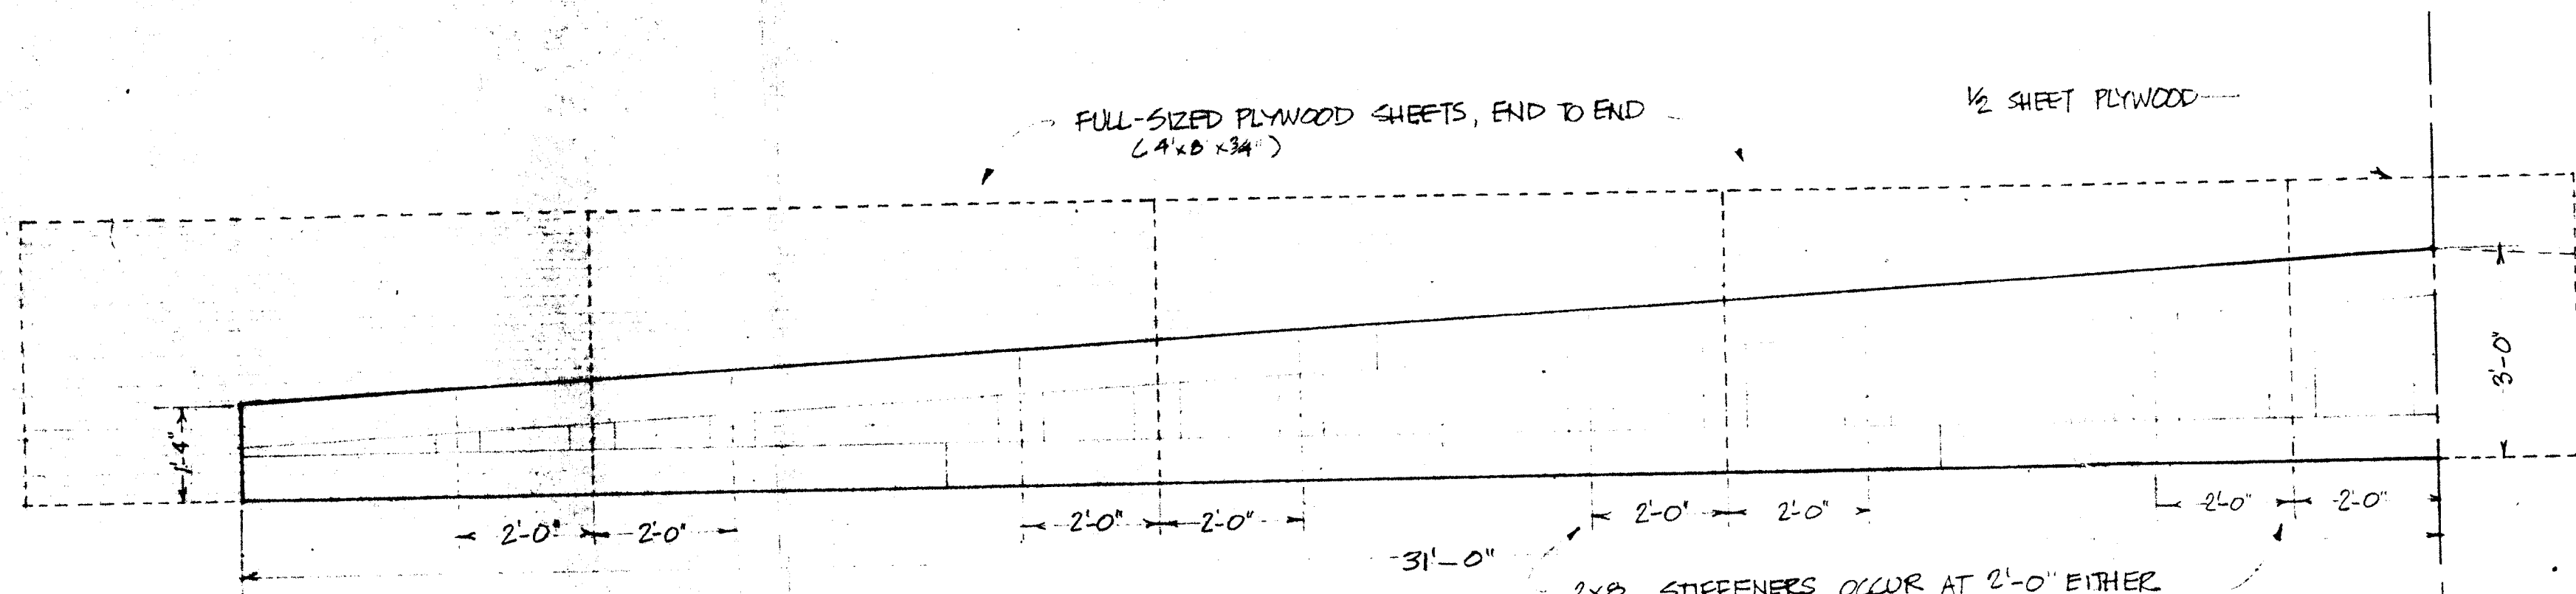


BEAM #1, CENTER LAYER

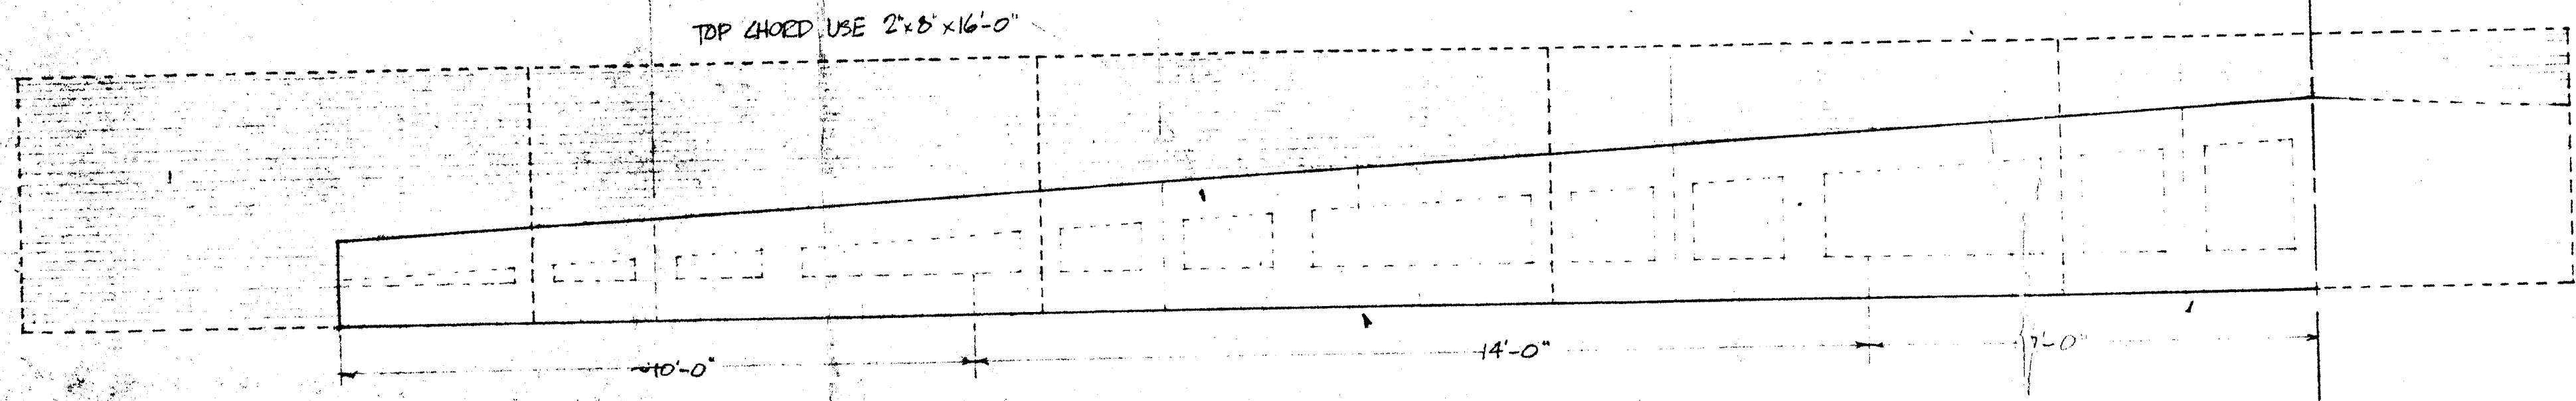


BEAM #1, EXTERNAL LAYERS

NOTE:
 HAUNCH & COMPOSITE BEAM CONSTRUCTION ARE THE SAME EXCEPT THAT:
 A) HAUNCH IS FRAMED WITH 2x12'S
 B) HAUNCH HAS EXTRA 1/4" PLY. COVER LAYERS BOTH SIDES

LONGWOOD PLYWOOD BANDROLL #
 5

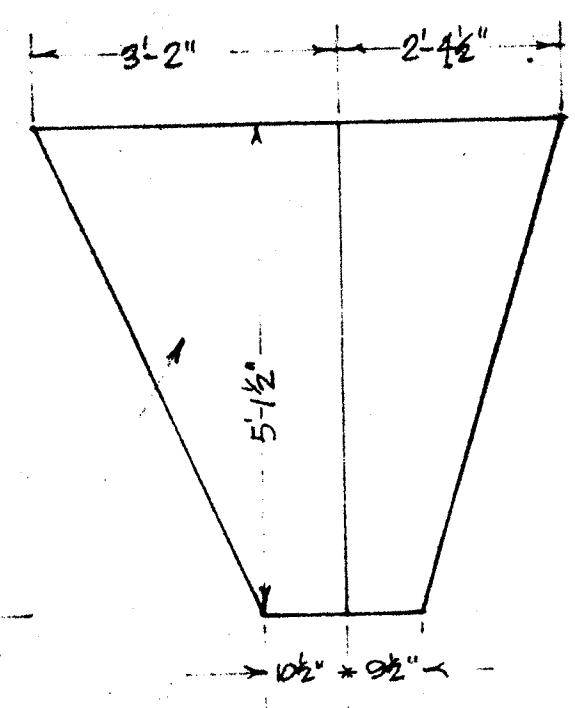


DIMENSIONS FOR 1/4" PLYWOOD OUTSIDE COVER LAYER


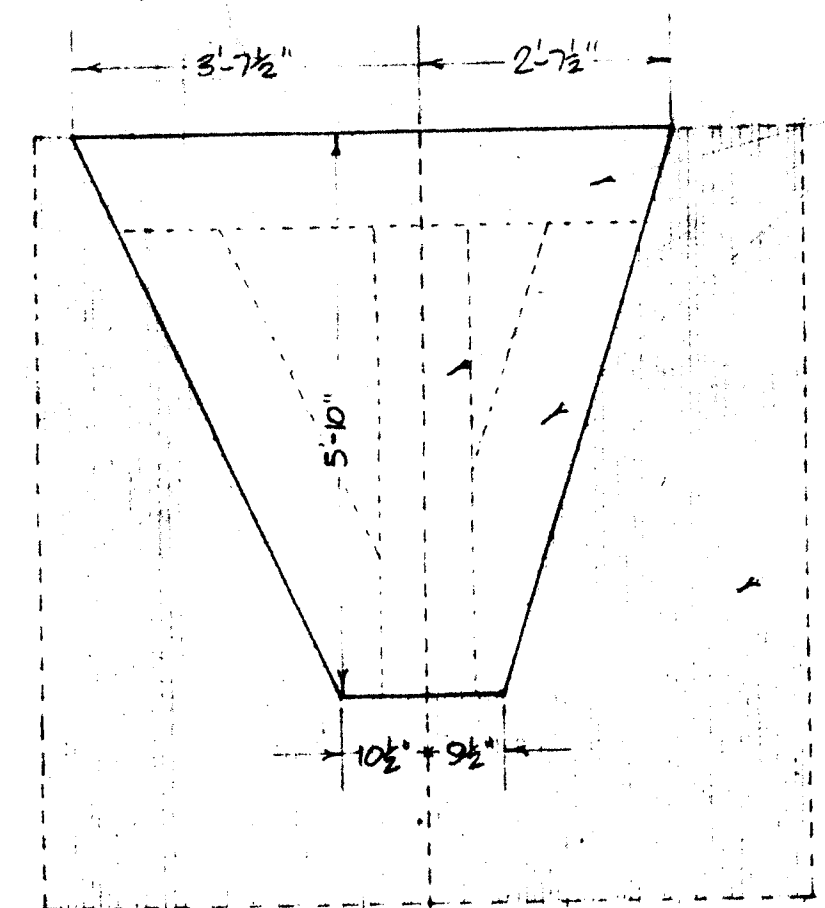


FULL SIZED PLYWOOD SHEET (4'x8'x3/4")

HAUNCH CONSTRUCTION DIAGRAMS

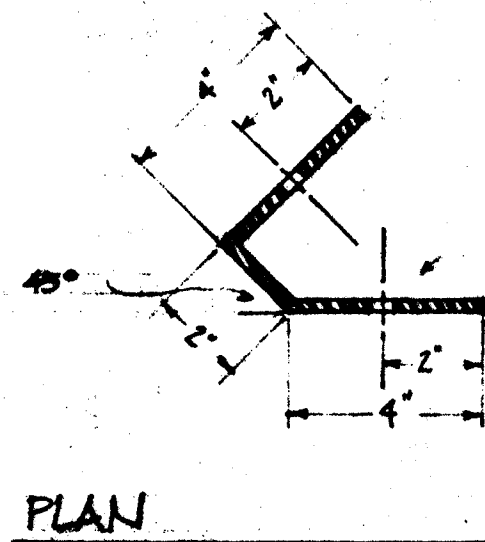


FABRICATE FROM $\frac{1}{4}$ " STEEL PLATE.
ALL HOLES DRILL $\frac{1}{2}$ " DIA.
3 IN EACH SURFACE AS SHOWN.

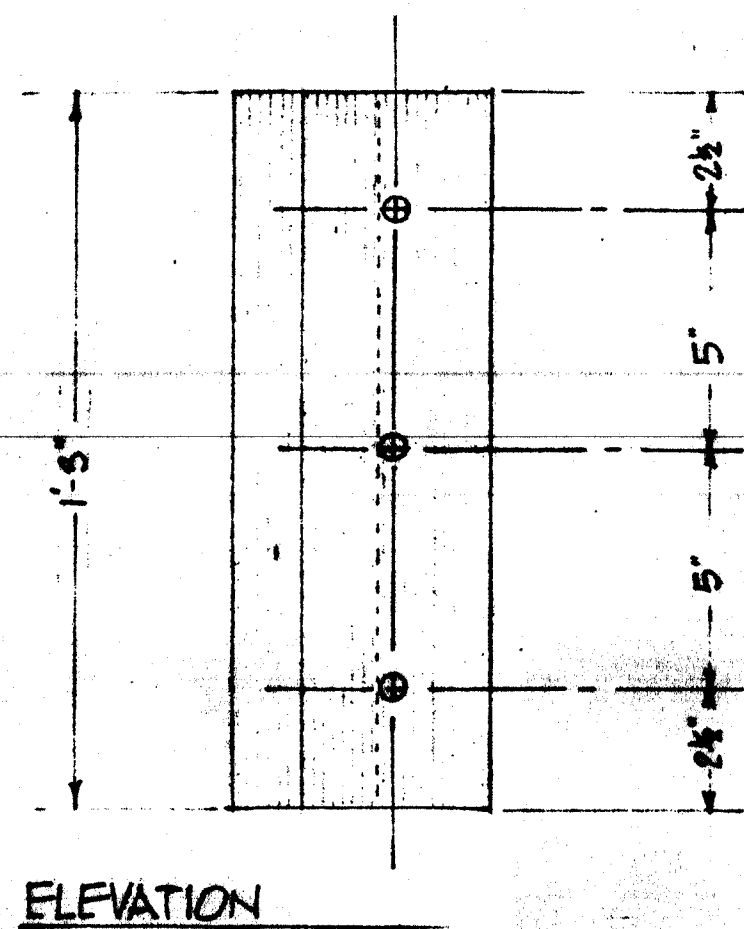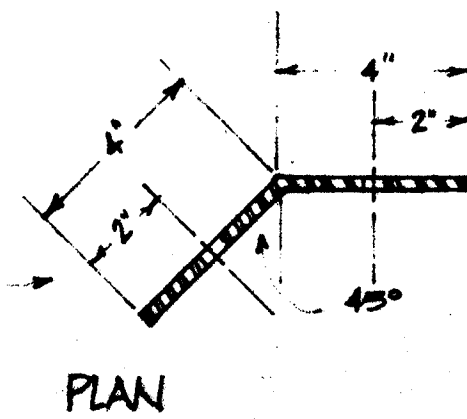


EDGE BEAM BRACKET #1 (6 REQ'D)

SCALE: 3"=1'-0"

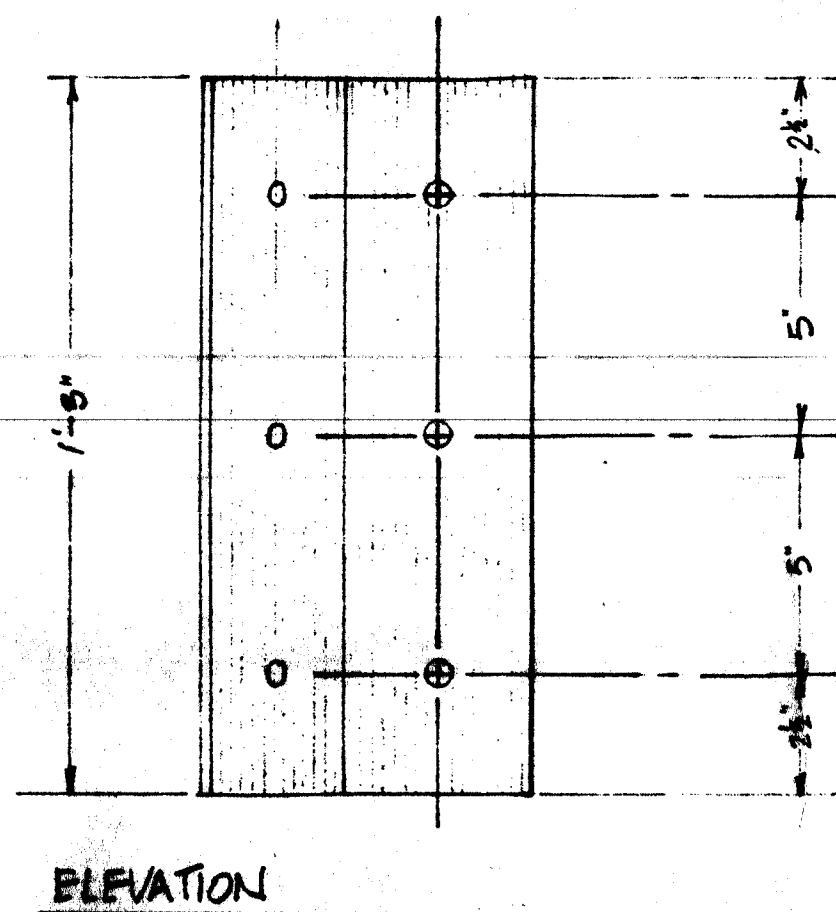

EDGE BEAM BRACKET #2 (4 REQ'D)

SCALE: 3"=1'-0"

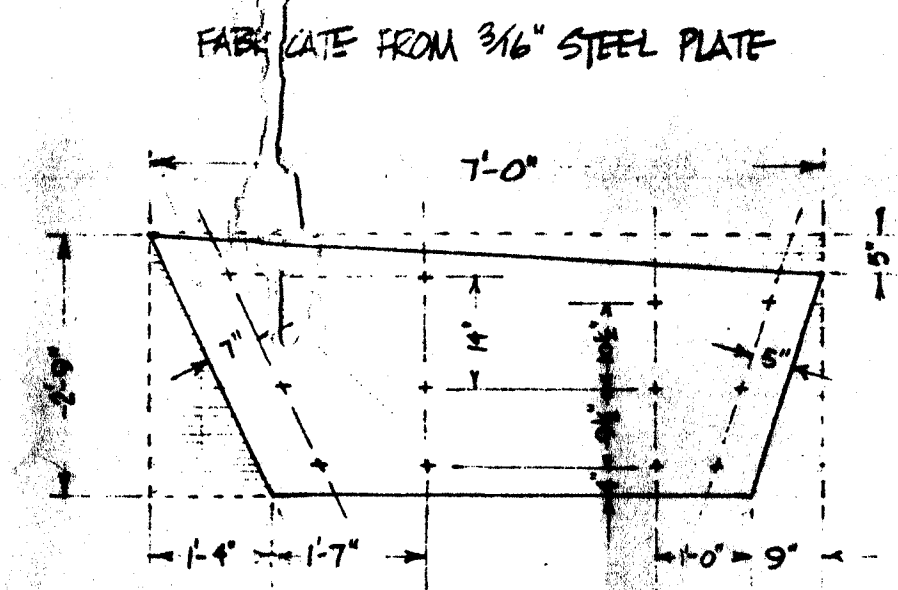

FABRICATE FROM $\frac{3}{16}$ " STEEL PLATE

ALL HOLES DRILL $\frac{3}{4}$ " DIA.

HAUNCH PLATE DIAGRAM (4 REQ'D)

SCALE: 1/2"=1'-0"

LAUNDREY
BRANDSILL #

6